GENERAL NOTES


- 1. BOUNDARY AND TOPOGRAPHIC INFORMATION IS BASED UPON A SURVEY PREPARED BY MILONE & MACBROOM INC. ENTITLED, "SURVEY WORKSHEET - BERLIN SIDEWALKS", FOR THE TOWN OF BERLIN, CONNECTICUT." DATED MARCH 23, 2016.
- 2. FOR A PORTION OF KENSINGTON ROAD, BOUNDARY AND TOPOGRAPHIC INFORMATION IS BASED UPON A SURVEY PREPARED BY PEREIRA ENGINEERING LLC. ENTITLED, "IMPROVEMENT LOCATION SURVEY" FOR THE TOWN OF BERLIN, CONNECTICUT." DATED MARCH 29, 2016. REVISED AUGUST 12, 2016.
- NORTH ARROW IS BASED UPON THE CONNECTICUT STATE PLANE. COORDINATE SYSTEM (NAD 1983) ESTABLISHED BY GPS. ELEVATIONS, CONTOURS, AND BENCHMARKS ARE BASED UPON NAVD 1988 ESTABLISHED BY GPS.
- 4. STREET LINES AND PROPERTY LINES ARE FROM THE TOWN OF BERLIN GIS.
- 5. INFORMATION REGARDING THE LOCATION OF EXISTING UTILITIES HAS BEEN BASED UPON AVAILABLE INFORMATION, MAY BE INCOMPLETE, AND WHERE SHOWN SHOULD BE CONSIDERED APPROXIMATE. THE LOCATION OF ALL EXISTING UTILITIES SHOULD BE CONFIRMED PRIOR TO BEGINNING CONSTRUCTION. CALL "CALL BEFORE YOU DIG", 1-800-922-4455. ALL UTILITY LOCATIONS THAT DO NOT MATCH THE VERTICAL OR HORIZONTAL CONTROL SHOWN ON THE PLANS SHALL IMMEDIATELY BE BROUGHT TO THE ATTENTION OF THE ENGINEER FOR RESOLUTION.
- 6. THE CONTRACTOR SHALL RESET ALL UTILITY GATE BOXES ENCOUNTERED DURING THE ENTIRETY OF THE WORK AT THEIR OWN COST.
- 7. MILONE & MACBROOM INC. ACCEPTS NO RESPONSIBILITY FOR THE ACCURACY OF MAPS AND DATA WHICH HAVE BEEN SUPPLIED BY OTHERS.
- 8. ALL DIMENSIONS AND ELEVATIONS SHALL BE VERIFIED IN THE FIELD PRIOR TO CONSTRUCTION. ANY DISCREPANCIES SHALL BE BROUGHT TO THE ATTENTION OF THE ENGINEER.
- 9. SEDIMENT AND EROSION CONTROL MEASURES AS DEPICTED ON THESE PLANS SHALL BE IMPLEMENTED AND MAINTAINED UNTIL PERMANENT COVER AND STABILIZATION IS ESTABLISHED. ALL SEDIMENT AND EROSION CONTROL MEASURES SHALL CONFORM TO THE "GUIDELINES FOR SOIL EROSION AND SEDIMENT CONTROL, CONNECTICUT - 2002, AND IN ALL CASES BEST MANAGEMENT PRACTICES SHALL PREVAIL.
- 10. ALL DISTURBED AREAS SHALL RECEIVE A MINIMUM OF 6" TOPSOIL, AND BE SEEDED WITH GRASS.
- 11. ALL PROPOSED CONTOURS AND SPOT ELEVATIONS INDICATE FINISHED GRADE.
- 12. ALL CONSTRUCTION MATERIALS AND METHODS SHALL CONFORM TO THE TOWN OF BERLIN REQUIREMENTS AND TO THE APPLICABLE SECTIONS OF THE STATE OF CONNECTICUT DEPARTMENT OF TRANSPORTATION STANDARD SPECIFICATIONS FOR ROADS, BRIDGES, AND INCIDENTAL CONSTRUCTION, FORM 817 AND ADDENDUMS
- 13. THE PLANS REQUIRE A CONTRACTOR'S WORKING KNOWLEDGE OF LOCAL, MUNICIPAL, WATER AUTHORITY, AND STATE CODES FOR UTILITY SYSTEMS. ANY CONFLICTS BETWEEN MATERIALS AND LOCATIONS SHOWN, AND LOCAL REQUIREMENTS SHALL BE BROUGHT TO THE ATTENTION OF THE ENGINEER PRIOR TO THE EXECUTION OF WORK. THE ENGINEER WILL NOT BE HELD LIABLE FOR COSTS INCURRED TO IMPLEMENT OR CORRECT WORK WHICH DOES NOT CONFORM TO LOCAL CODE.
- 14. COMPLIANCE WITH THE PERMIT CONDITIONS IS THE RESPONSIBILITY OF BOTH THE CONTRACTOR AND THE PERMITTEE.

CONSTRUCTION SEQUENCE

- 1. CALL "CALL BEFORE YOU DIG" FOR MARK OUT OF ALL UTILITIES.
- 2. PRIOR TO COMMENCEMENT OF WORK A PRE CONSTRUCTION MEETING SHALL BE HELD WITH TOWN STAFF AND REPRESENTATIVES OF THE CONTRACTOR.
- 3. CONSTRUCT SIDEWALKS AND OTHER SITE IMPROVEMENTS AS SHOWN.
- 4. PERMANENTLY STABILIZE ALL DISTURBED AREAS.
- 5. COMPLETE ALL SIGNAGE AND PAVEMENT MARKINGS.

LEGEND

	STREET LINE
	PROPERTY LINE
·····	WATERCOURSE
	WETLAND
uuu	TREELINE
OHW	OVERHEAD WIRES
o o o	GUARDRAIL
oo	CHAIN LINK FENCE
Ø	DRAINAGE MANHOLE
S	SANITARY MANHOLE
\bigotimes	MANHOLE
	CATCH BASIN
• _{WV}	WATER VALVE
• _{BO}	BOLLARD
• _{GP}	GATE POST
• GM	GAS METER
• _{RD}	ROOF DRAIN
С	UTILITY POLE
¥	HYDRANT
¢	LIGHT POLE
	SIGN
O IP	IRON PIPE FOUND
8	MONITOR WELL
O	IRON PIN FOUND
© MON	CONCRETE MONUMENT FOUND
\succ	GUY WIRE

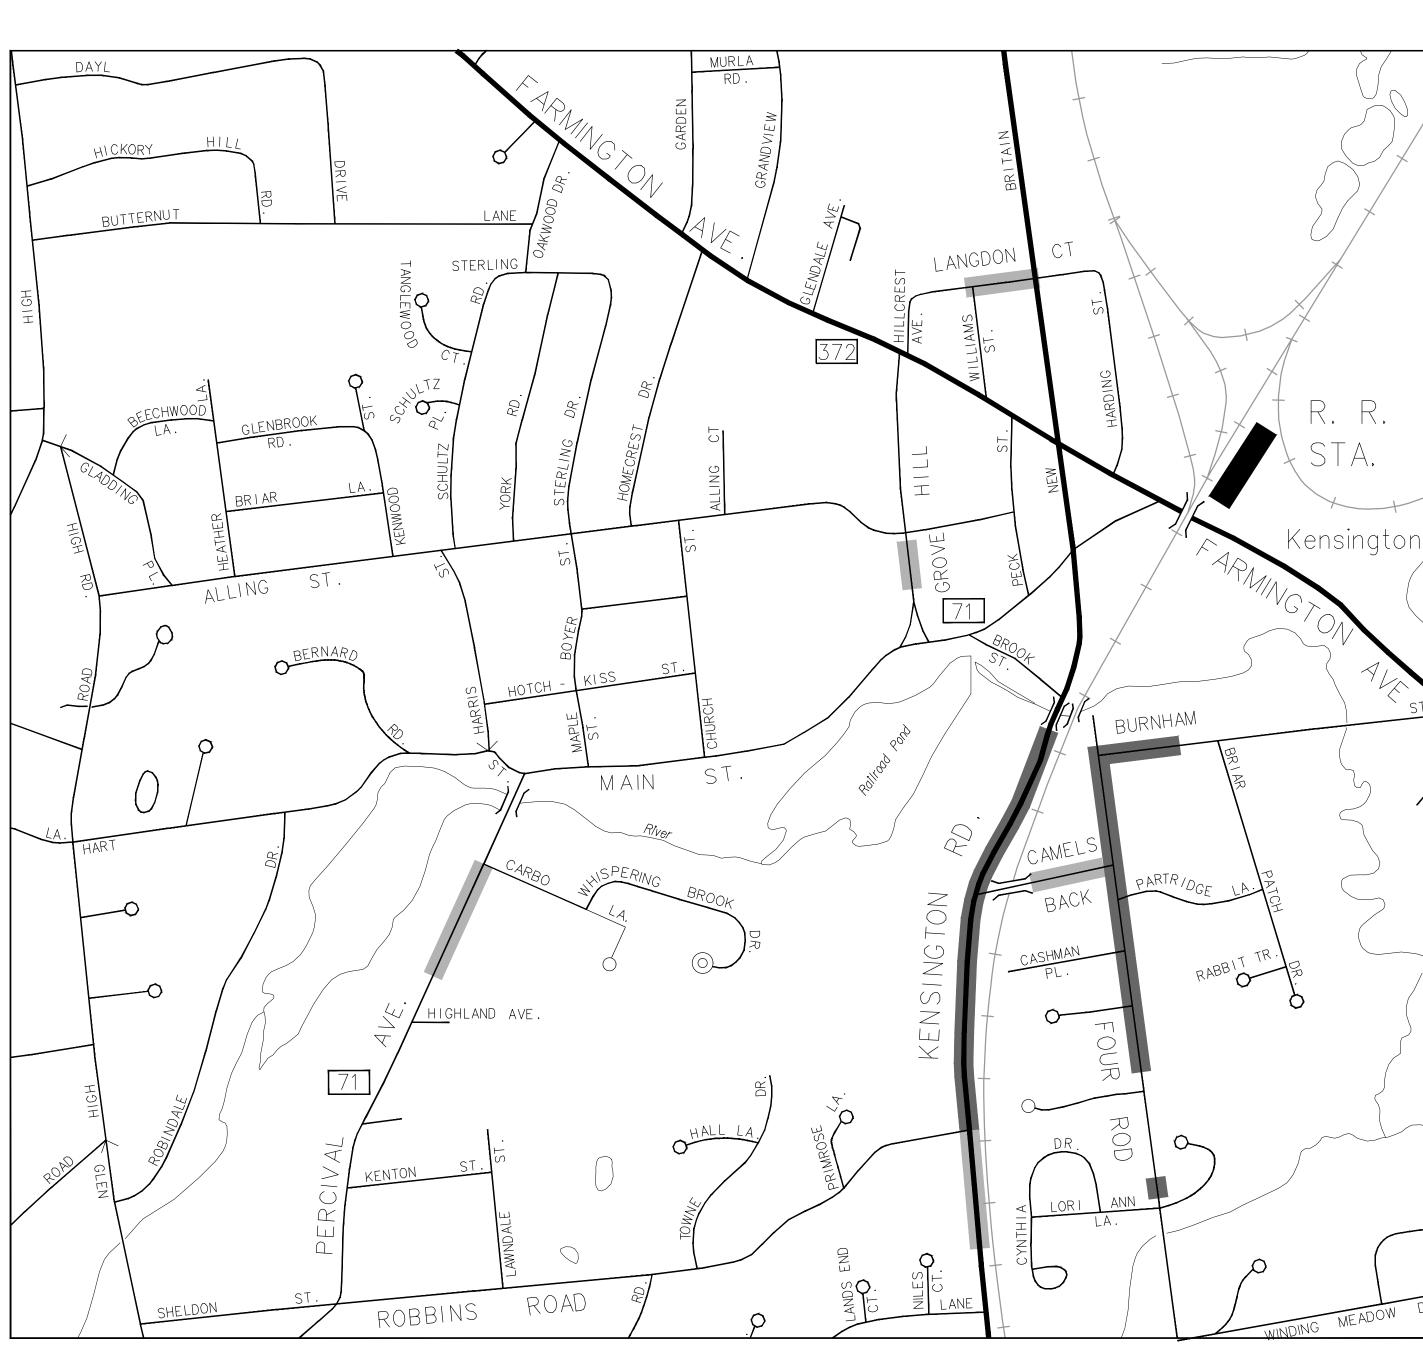


Only Drawings Related to Percival Ave are included in this set BERLIN SIDEWALK IMPROVEMENTS

BERLIN, CONNECTICUT

BID DOCUMENTS SEPTEMBER 23, 2016


PROJECT SITE VICINITY MAP:

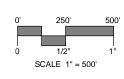

PREPARED BY:



99 Realty Drive Cheshire, Connecticut 06410 (203) 271-1773 Fax (203) 272-9733 www.miloneandmacbroom.com

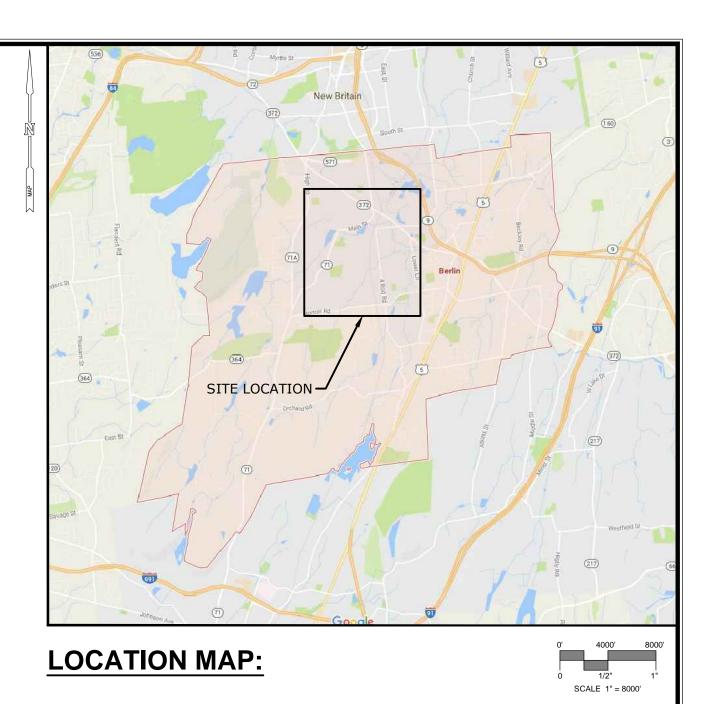

PREPARED FOR:

DEPARTMENT OF PUBLIC WORKS TOWN OF BERLIN 240 KENSINGTON ROAD BERLIN, CONNECTICUT 06037

LIST OF DRAWINGS


NAME	TITLE
	TITLE SHEET
INDEX	INDEX PLAN
EX-1 TO 11	EXISTING CONDITIONS
LA-1	SITE PLAN - NEWTON STREET
LA-2	SITE PLAN - LANGDON COURT
LA-3	SITE PLAN - GROVE HILL STREET
LA-4	SITE PLAN - BURNHAM STREET AND FOUR ROD ROAD
LA-5	SITE PLAN - FOUR ROD ROAD AND CAMELS BACK
LA-6	SITE PLAN - FOUR ROD ROAD
LA-7	SITE PLAN - KENSINGTON ROAD
LA-8	SITE PLAN - KENSINGTON ROAD
LA-9	SITE PLAN - KENSINGTON ROAD
LA-10	SITE PLAN - KENSINGTON ROAD
LA-11	SITE PLAN - PERCIVAL AVENUE
CS-1	CROSS SECTIONS
SD-1	SITE DETAILS
SD-2	SITE DETAILS
	 INDEX EX-1 TO 11 LA-1 LA-2 LA-3 LA-4 LA-5 LA-6 LA-7 LA-8 LA-9 LA-10 LA-11 CS-1 SD-1


ADD ALTERNATES

ADD ALTERNATE NO. 1:	SEE SHEET LA-1
ADD ALTERNATE NO. 2:	SEE SHEET LA-2
ADD ALTERNATE NO. 3:	SEE SHEET LA-3
ADD ALTERNATE NO. 4:	SEE SHEET LA-5
ADD ALTERNATE NO. 5:	SEE SHEET LA-7
ADD ALTERNATE NO. 6:	SEE SHEET LA-11



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- 8. TREE REMOVALS ARE TO INCLUDE ALL TREE STUMPS.

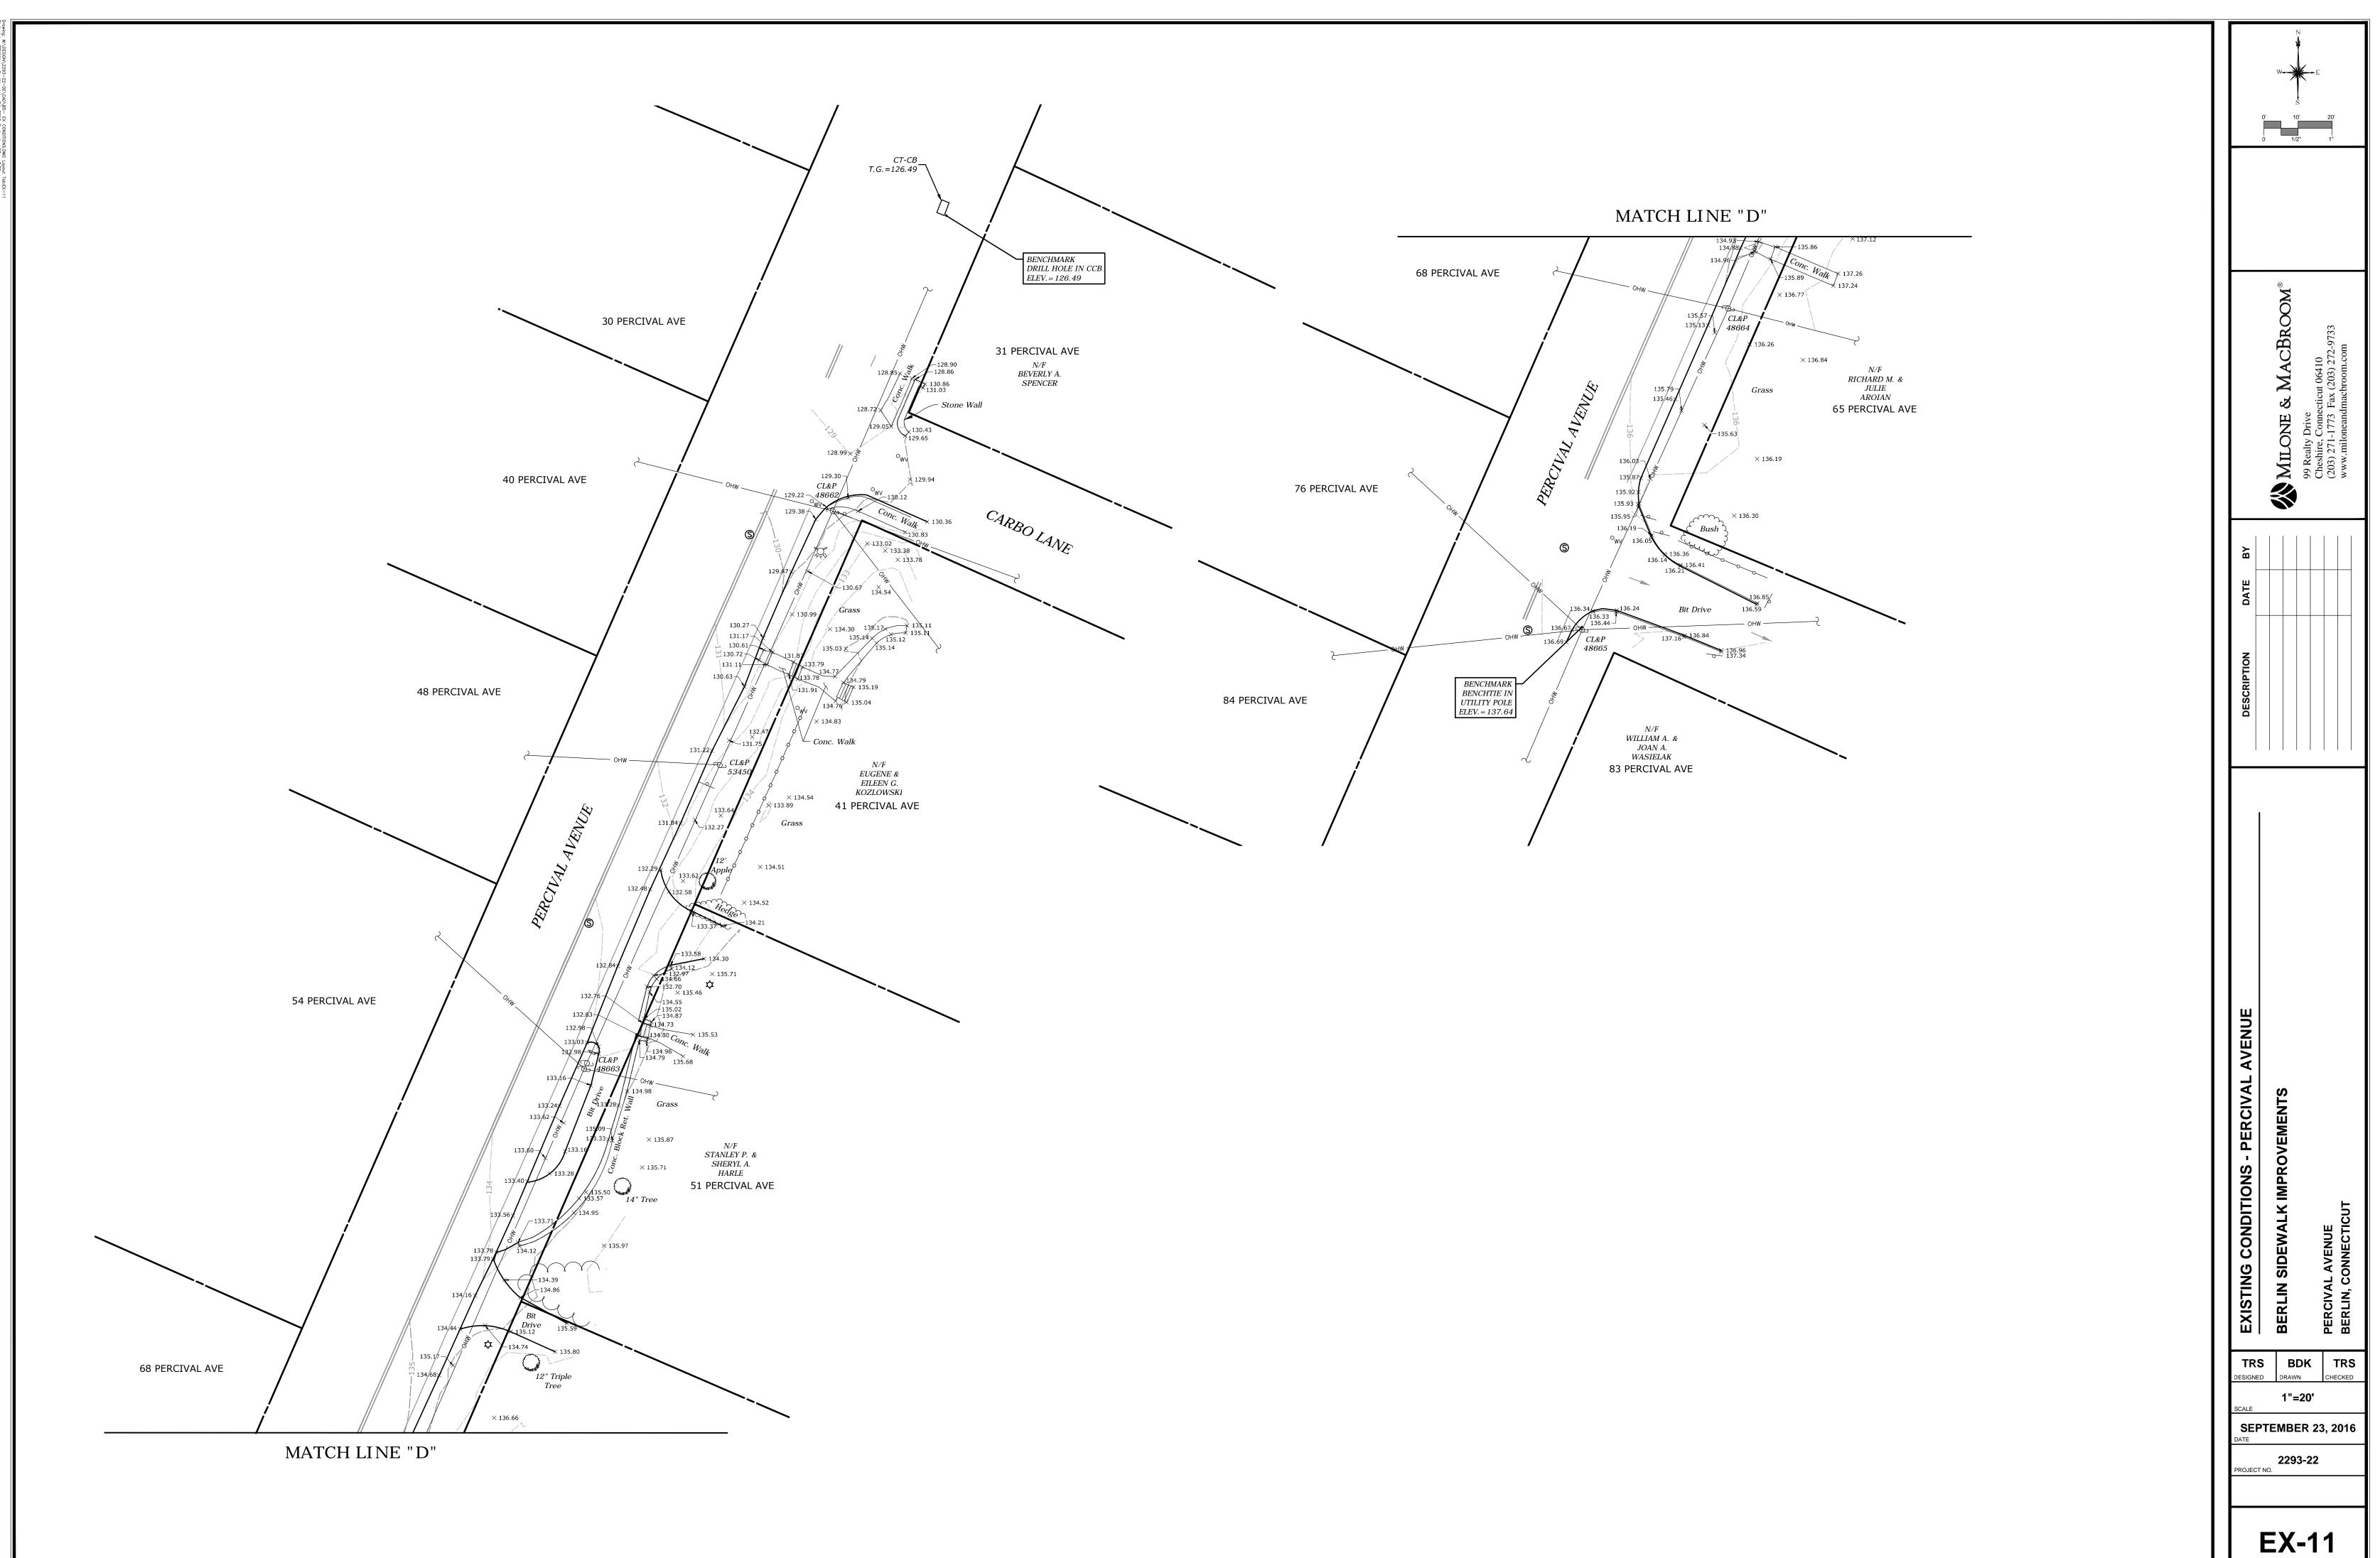T DOT		
	1 WORK	۱

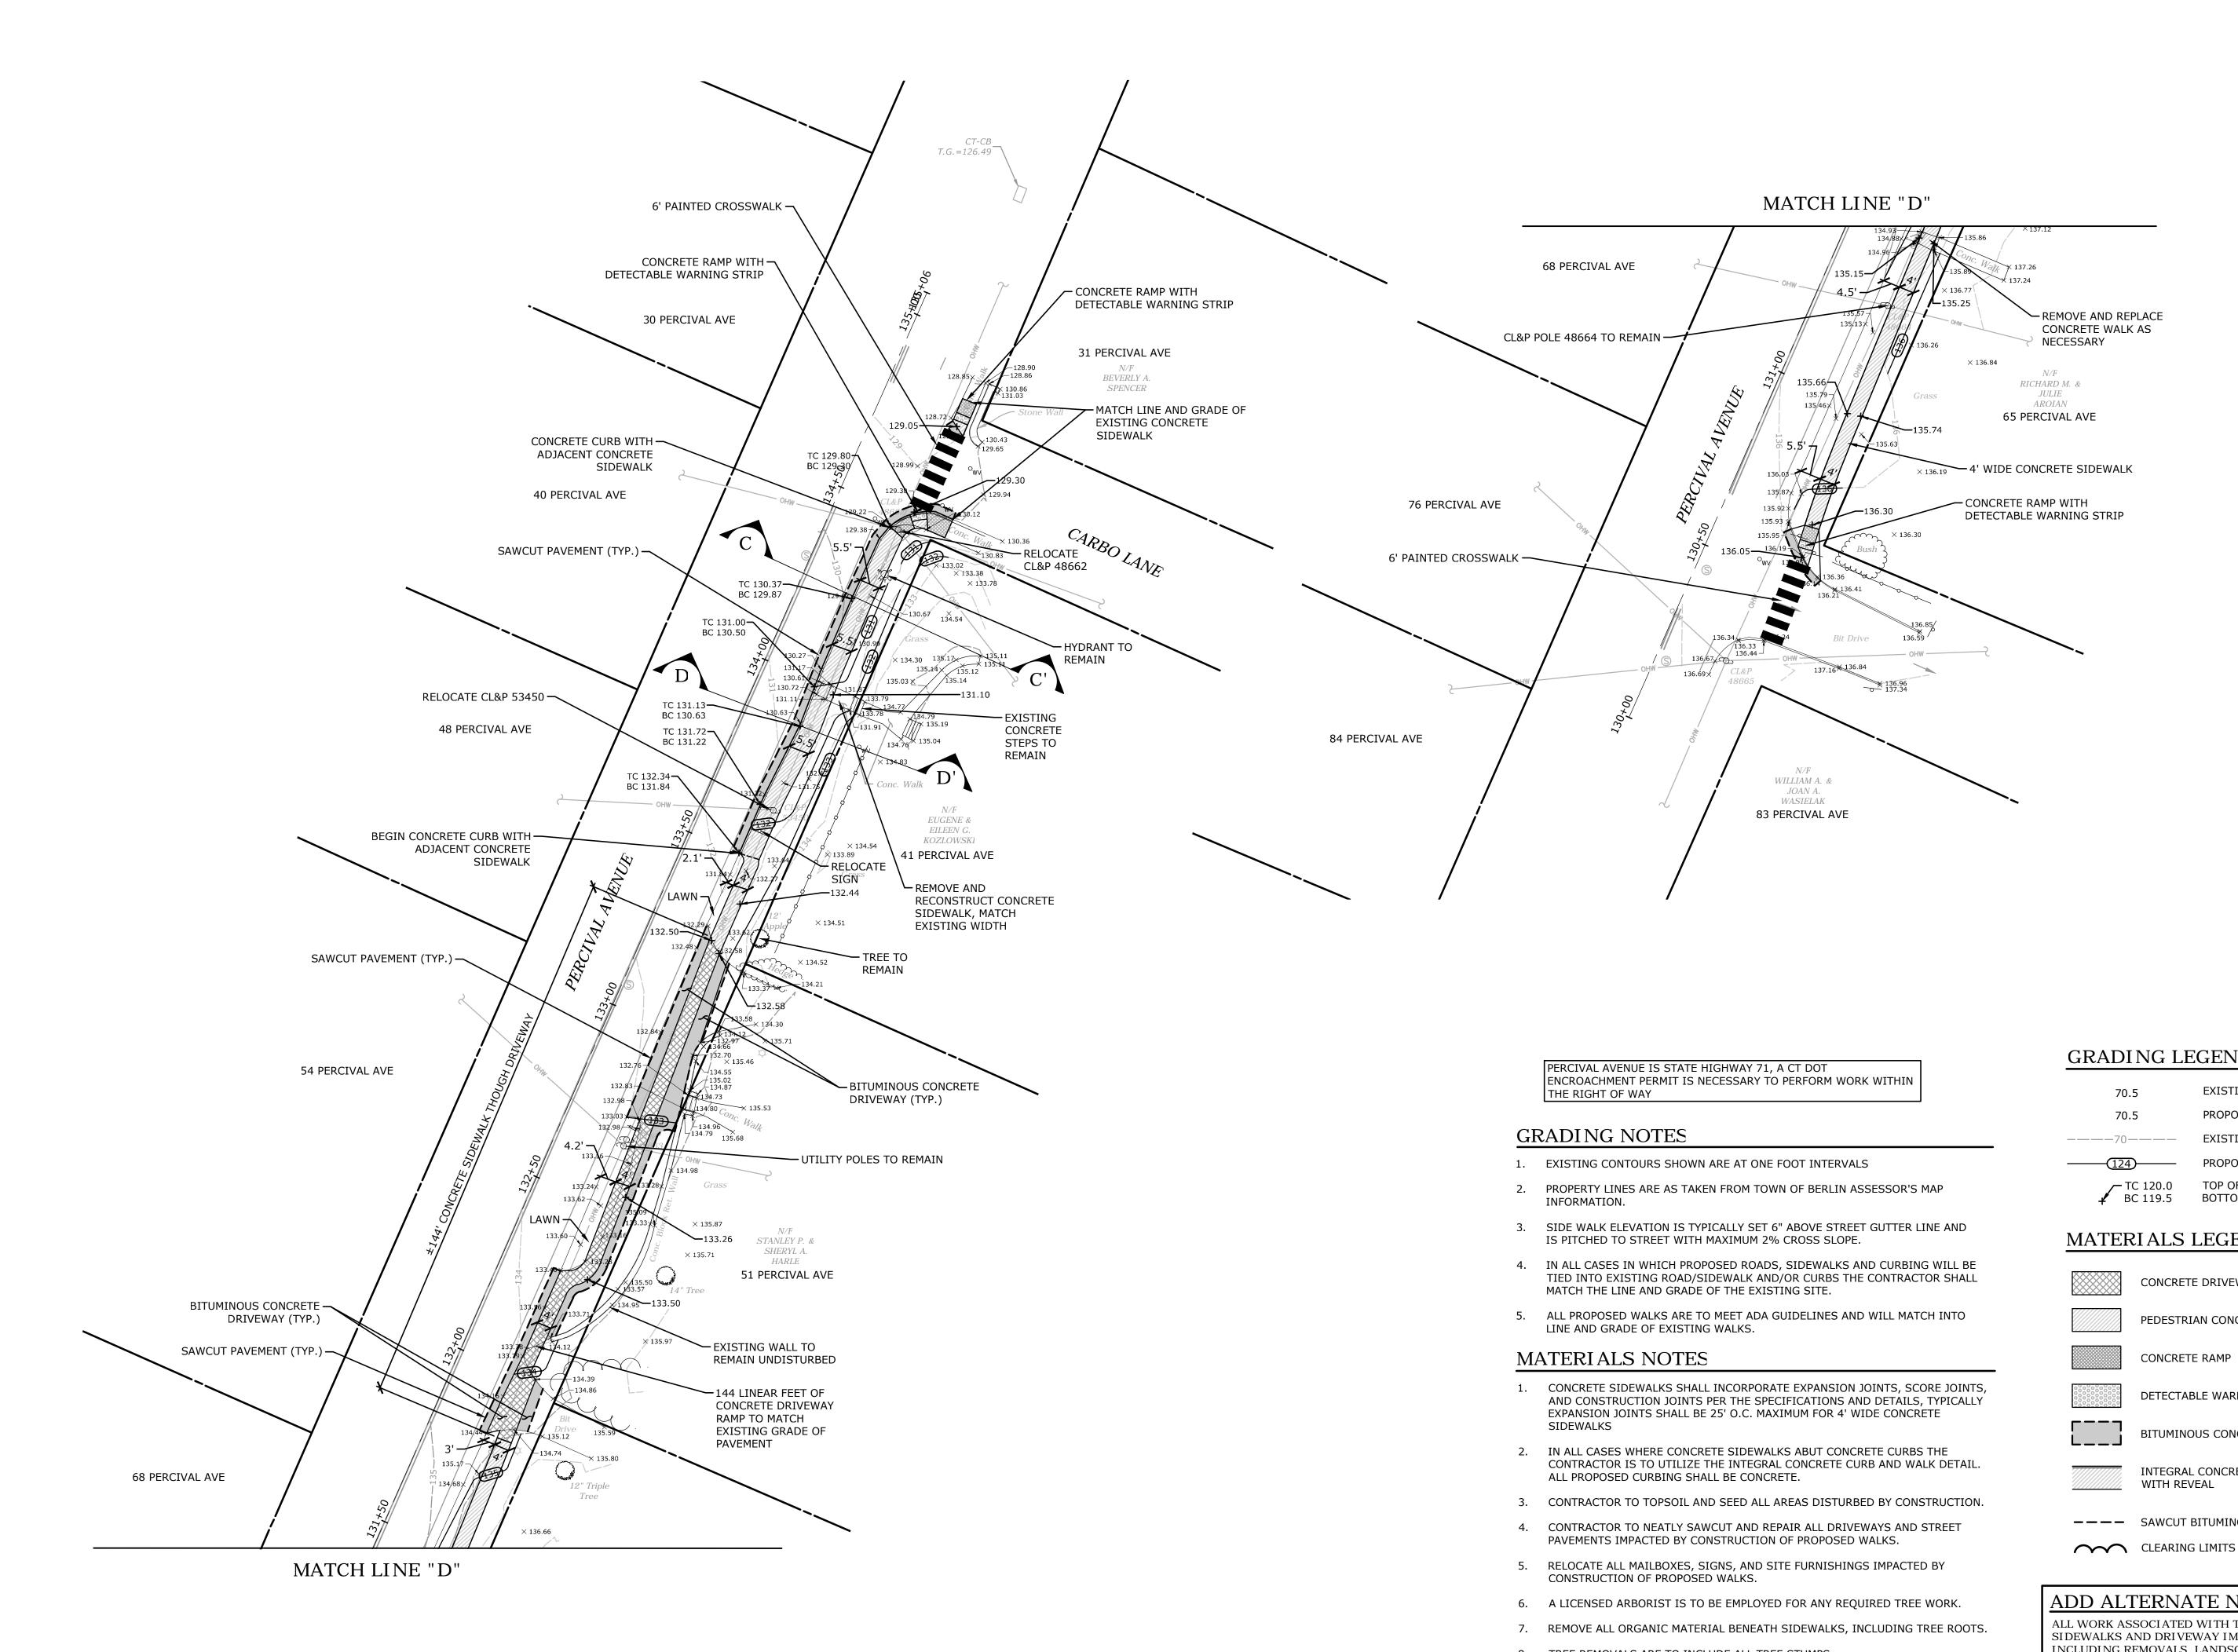GRADING LEGEND

70.5
70.5
—————70————
(124)
TO 100 0

EXISTING SPOT ELEVATION PROPOSED SPOT ELEVATION EXISTING CONTOUR — PROPOSED CONTOUR TOP OF CURB BC 119.5 BOTTOM OF CURB

MATERIALS LEGEND

CONCRETE DRIVEWAY RAMP
PEDESTRIAN CONCRETE SIDEWALK
CONCRETE RAMP
DETECTABLE WARNING STRIP
BITUMINOUS CONCRETE REPAIR
INTEGRAL CONCRETE WALK & CURB WITH REVEAL
 SAWCUT BITUMINOUS CONCRETE

ADD ALTERNATE NO.6

ALL WORK ASSOCIATED WITH THE CONSTRUCTION OF SIDEWALKS AND DRIVEWAY IMPROVEMENTS INCLUDING REMOVALS, LANDSCAPING, AND DRAINAGE CONNECTIONS ON PERCIVAL AVENUE FROM STATION 130+00 TO STATION 135+06.

0				
	MILONE & MACBROOM®	Cheshire, Drive Cheshire, Connecticut 06410 (203) 271-1773 Fax (203) 272-9733 www.miloneandmacbroom.com		
DATE BY				
DESCRIPTION				
SITE PLAN - PERCIVAL AVENUE	BERLIN SIDEWALK IMPROVEMENTS	PERCIVAL AVENUE BERLIN, CONNECTICUT		
TRS DESIGNED SCALE SEPT DATE	DESIGNED DRAWN CHECKED 1"=20' SCALE SEPTEMBER 23, 2016			
	2293-22 PROJECT NO.			
SHEET NAM	LA-11 SHEET NAME			

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